


TOMPKINS COUNTY SOIL AND WATER CONSERVATION DISTRICT

SIX MILE CREEK AT BANKS ROAD MAINTENANCE REPAIRS

CONTRACT NO. 1 - GENERAL CONSTRUCTION

**BANKS ROAD, TOWN OF CAROLINE
TOMPKINS COUNTY, NEW YORK**


**Barton
& Loguidice**

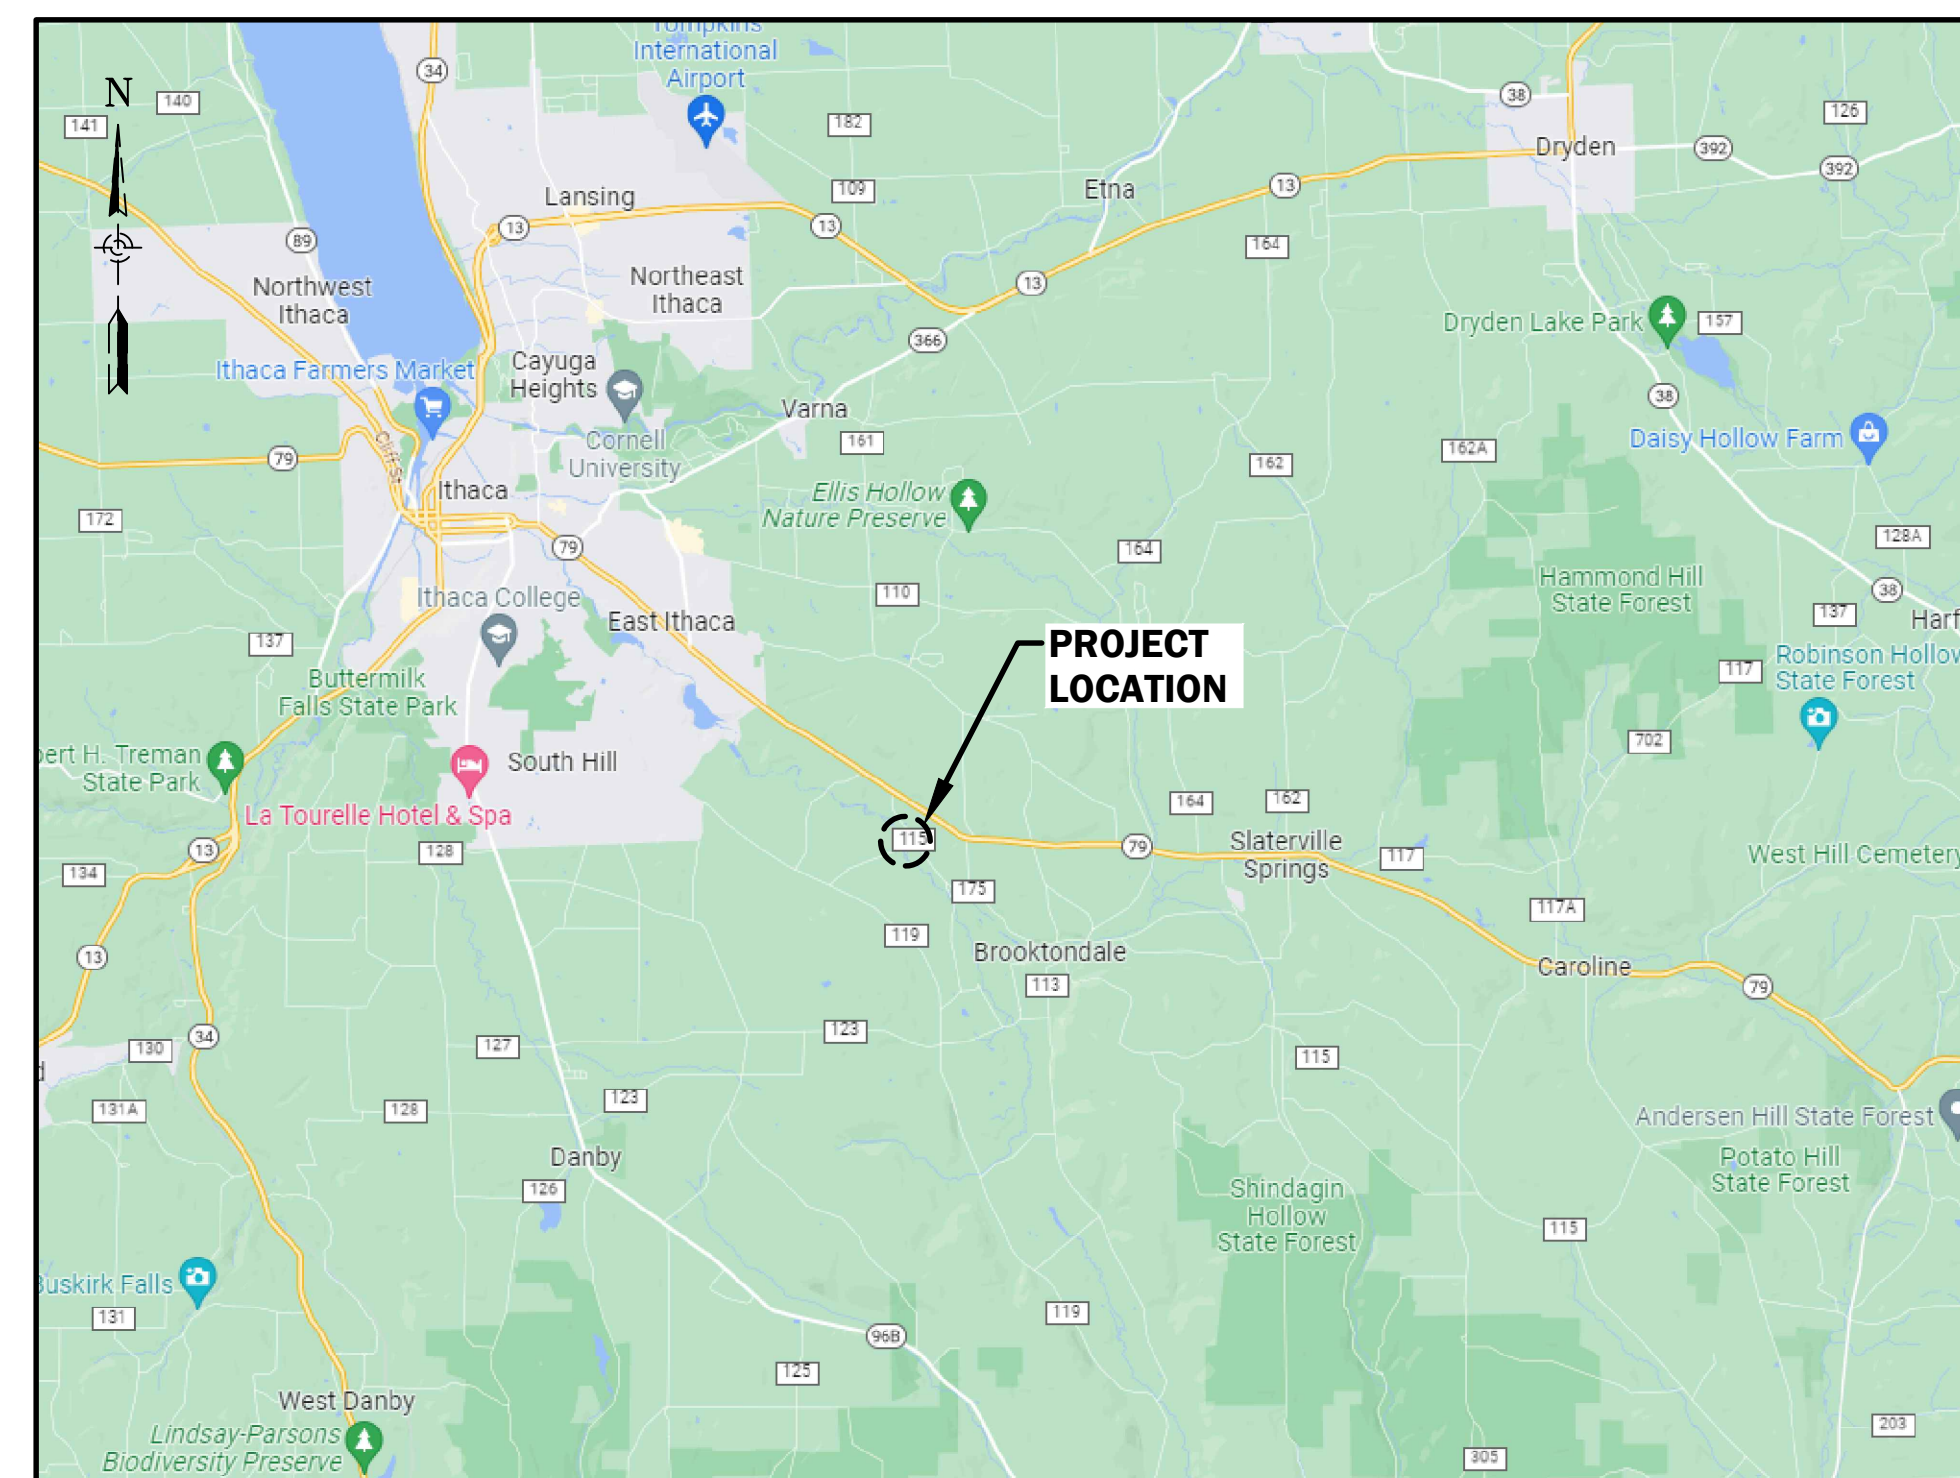

PROJECT LOCATION MAP

NOT TO SCALE

SEPTEMBER 2023
FOR REGULATORY REVIEW
NOT FOR CONSTRUCTION

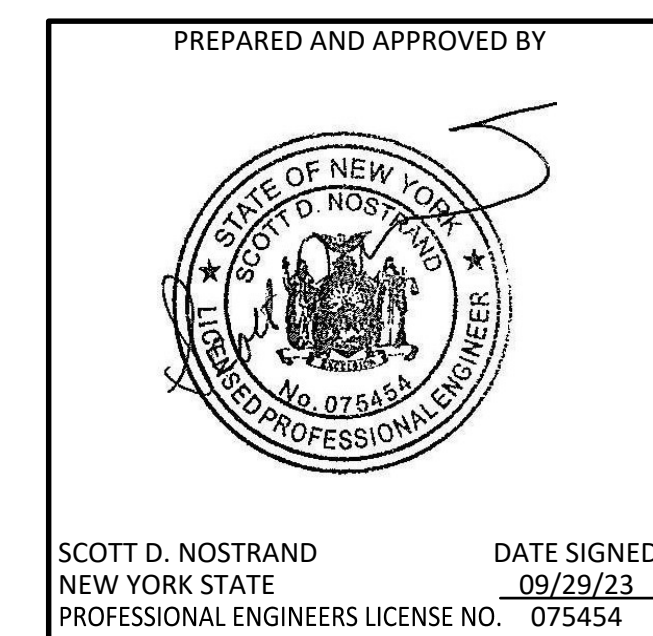

Sheet Number
G001
Project Number
1393.004.003

COORDINATE SYSTEM NOTES

- COORDINATES AND BEARINGS ARE BASED ON NAD83 NEW YORK STATE PLANE COORDINATE SYSTEM - CENTRAL ZONE (US SURVEY FEET). ELEVATIONS ARE BASED ON NAVD 88.

PROTECTION OF EXISTING VEGETATION

- EXISTING MATURE TREES AND ESTABLISHED WOODY SHRUBS ADJACENT TO THE LIMITS OF DISTURBANCE ARE TO BE PROTECTED TO THE EXTENT PRACTICABLE DURING CONSTRUCTION. CONTRACTOR SHALL CLEARLY DEMARCAT THE LIMITS OF DISTURBANCE. CONTACT THE ENGINEER TO APPROVE THE LIMITS IN THE FIELD PRIOR TO INITIATING CONSTRUCTION ACTIVITIES.
- CONTRACTOR SHALL FOLLOW THE STANDARDS AND SPECIFICATIONS FOR PROTECTING VEGETATION DURING CONSTRUCTION PUBLISHED IN THE 2016 BLUE BOOK, AS AMENDED.

SEQUENCE OF CONSTRUCTION

- INSTALL STABILIZED CONSTRUCTION ENTRANCE WHERE SHOWN ON THE SITE PLAN.
- STOCKPILE ALL PROJECT MATERIALS IN THE DESIGNATED STAGING AREA SHOWN ON THE PLANS. SOIL AND ROCK MATERIALS SHALL NOT BE PLACED WITHIN THE LIMITS OF THE FLOODPLAIN OR STREAM CHANNEL UNLESS THE MATERIAL IS BEING INCORPORATED INTO THE PROPOSED WORK IN THE SAME WORK DAY.
- INSTALL EROSION AND SEDIMENT (E&S) CONTROL MEASURES AS SHOWN ON THE SITE PLAN. THE SEQUENCE OF INSTALLATION AND REMOVAL OF E&S CONTROL MEASURES SHALL FOLLOW THE ORDER PRESENTED IN THIS SEQUENCE OF CONSTRUCTION UNLESS OTHERWISE APPROVED BY THE ENGINEER.
- MINIMIZE CLEARING AND GRUBBING TO ONLY THOSE AREAS WHERE WORK IS PROPOSED ON THE SITE PLAN. ACCESS TO THE STREAM CHANNEL SHALL OCCUR WITHIN THE LIMITS OF PROPOSED WORK AREAS TO AVOID UNNECESSARY DISTURBANCE.
- INSTALL COMPOST FILTER SOCK BETWEEN THE CONSTRUCTION ACCESS PATH AND THE STREAM CHANNEL.
- EXCAVATE A TEMPORARY DIVERSION CHANNEL AT THE UPSTREAM END OF THE WORK SITE. STOCKPILE ALL EXCAVATED STREAMBED MATERIAL FOR USE ON-SITE. DIVERT ALL NORMAL STREAM FLOW THROUGH THE TEMPORARY CHANNEL FOR THE DURATION OF IN-STREAM WORK BETWEEN STA 3+00 AND STA 5+08.
- SALVAGE EXPOSED BOULDERS FROM THE CROSS VANE NEAR STA 5+00 FOR REUSE IN THE J-HOOK.
- EXCAVATE AND CONSTRUCT THE J-HOOK NEAR STA 3+00.
- STARTING AT STA 3+00, RE-GRADE THE STREAMBED TO STATION 5+08 AT THE GRADE AND DIMENSIONS SHOWN ON THE PROFILE AND DETAILS.
- REMOVE THE TEMPORARY DIVERSION CHANNEL AT THE UPSTREAM END OF THE WORK SITE.
- RE-GRADE THE STREAMBANK BETWEEN STA 7+90 AND 10+09. INSTALL LIVE STAKES AT THE BANKFULL CHANNEL ELEVATION AT THE OPTION OF THE OWNER.
- EXCAVATE A TEMPORARY DIVERSION CHANNEL AT THE DOWNSTREAM END OF THE WORK SITE. STOCKPILE ALL EXCAVATED STREAMBED MATERIAL FOR USE ON-SITE. DIVERT ALL NORMAL STREAM FLOW THROUGH THE TEMPORARY CHANNEL FOR THE DURATION OF IN-STREAM WORK BETWEEN STA 11+21 AND STA 14+80.
- RE-GRADE THE STREAMBANK BETWEEN STA 11+72 AND STA 13+78. GRADING MAY PROCEED WITH THE CONSTRUCTION OF STONE TOE PROTECTION SHOWN ON THE SITE PLAN.
- STARTING AT STA 11+21, RE-GRADE THE STREAMBED TO STATION 14+80 AT THE GRADE AND DIMENSIONS SHOWN ON THE PROFILE AND DETAILS.
- REMOVE THE TEMPORARY DIVERSION CHANNEL AT THE DOWNSTREAM END OF THE WORK SITE.
- REMOVE ANY REMAINING STOCKPILED STREAMBED OR STREAMBANK MATERIALS FROM THE PROJECT SITE. DISPOSAL OF MATERIALS SHALL BE AT A PERMITTED SITE SELECTED BY THE CONTRACTOR. MATERIALS SHALL NOT BE DEPOSITED IN AREAS OF THE STREAM CHANNEL OR FLOODPLAIN AT THE WORK SITE.
- REMOVE THE STABILIZED CONSTRUCTION ENTRANCE.
- SEED AND MULCH ANY REMAINING DISTURBED AREAS WITH THE RESTORATION SEED MIX. REMOVE COMPOST FILTER SOCK AND ANY REMAINING E&S CONTROL MEASURES ONCE FINAL STABILIZATION IS ACHIEVED.

RESTORATION SEED MIX

COVER CROP AND RESTORATION SEED MIX SHOULD BE APPLIED SIMULTANEOUSLY AT A COMBINED RATE OF 50 LB./ACRE. SOW SEED BETWEEN AUGUST 15 AND OCTOBER 1, OR AS OTHERWISE APPROVED BY THE ENGINEER.












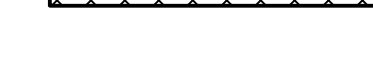

COVER CROP - 30 LB/ACRE

100% GRAIN RYE (SECALE CEREALE)

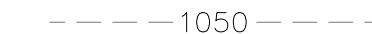MIX COMPOSITION (ERNMX-154 OR APPROVED EQUAL) - 20 LB/ACRE

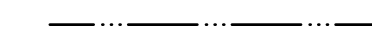- 20.0% VIRGINIA WILD RYE (ELYMUS VIRGINICUS)
- 14.5% DEERTONGUE (PANICUM CLANDESTINUM)
- 14.0% BIG BLUESTEM (ANDROPOGON GERARDII)
- 14.0% INDIANGRASS (SORGHASTRUM NUTANS)
- 10.0% FOX SEDGE (CAREX VULPINOIDEA)
- 6.3% LURID SEDGE (CAREX LURIDA)
- 6.3% BLUNT BROOM SEDGE (CAREX SCOPARIA)
- 3.0% BLUE VERVAIN (VERBENA HASTATA)
- 2.0% SWAMP MILKWEED (ASCLEPIAS INCARNATA)
- 2.0% SOFT RUSH (JUNCUS EFFUSUS)
- 2.0% GOLDEN ALEXANDERS (ZIZIA AUREA)
- 1.0% WHITE VERVAIN (VERBENA URTICIFOLIA)
- 0.6% WRINKLELEAF GOLDENROD (SOLIDAGO RUGOSA)
- 0.5% LANCE LEAVED ASTER (ASTER LANCEOLATUS)
- 0.5% NEW ENGLAND ASTER (ASTER NOVAE-ANGLIAE)
- 0.5% PURPLESTEM ASTER (ASTER PUNICEUS)
- 0.5% COMMON SNEEZEWEED (HELENIUM AUTUMNALE)
- 0.4% BONESET (EUPATORIUM PERFOLIATUM)
- 0.4% GRASSLEAF GOLDENROD (EUTHAMIA GRAMINIFOLIA)
- 0.4% WILD BERGAMOT (MONARDA FISTULOSA)
- 0.3% AMERICAN WATER HOREHOUND (LYCOPUS AMERICANUS)
- 0.3% SQUARE STEMMED MONKEYFLOWER (MIMULUS RINGENS)
- 0.3% WOOLGRASS (SCIRPUS CYPERINUS)
- 0.2% GREAT BLUE LOBELIA (LOBELIA SIPHILITICA)

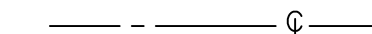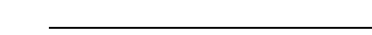LEGEND

-  EXISTING MAJOR CONTOUR (5' INTERVAL)
-  EXISTING MINOR CONTOUR (1' INTERVAL)
-  LIMIT OF GRADING
-  BANKFULL LIMITS
-  ORDINARY HIGH WATER LINE
-  FILTER SOCK
-  EXISTING STREAM CENTERLINE
-  EXISTING STREAM THALWEG
-  ROCK TOE PROTECTION
-  J-HOOK
-  TEMPORARY DIVERSION CHANNEL
-  TEMPORARY ACCESS ROUTE AND STAGING AREA
-  STREAMBANK REGRADING


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REVISIONS	

TOMPKINS COUNTY SOIL AND WATER CONSERVATION DISTRICT
 SIX MILE CREEK AT BANKS ROAD MAINTENANCE REPAIRS
GENERAL NOTES AND LEGEND
 TOMPKINS COUNTY, NEW YORK
 TOWN OF CAROLINE


443 Electronics Parkway
 Liverpool, NY
 13088

Barton & Loguidice, D.P.C.

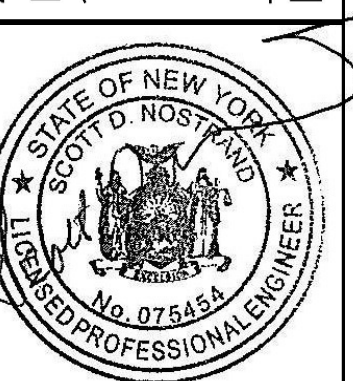

Date	SEPTEMBER 2023
Scale	AS SHOWN
Sheet Number	G002
Project Number	1393.004.003

FOR REGULATORY REVIEW - NOT FOR CONSTRUCTION

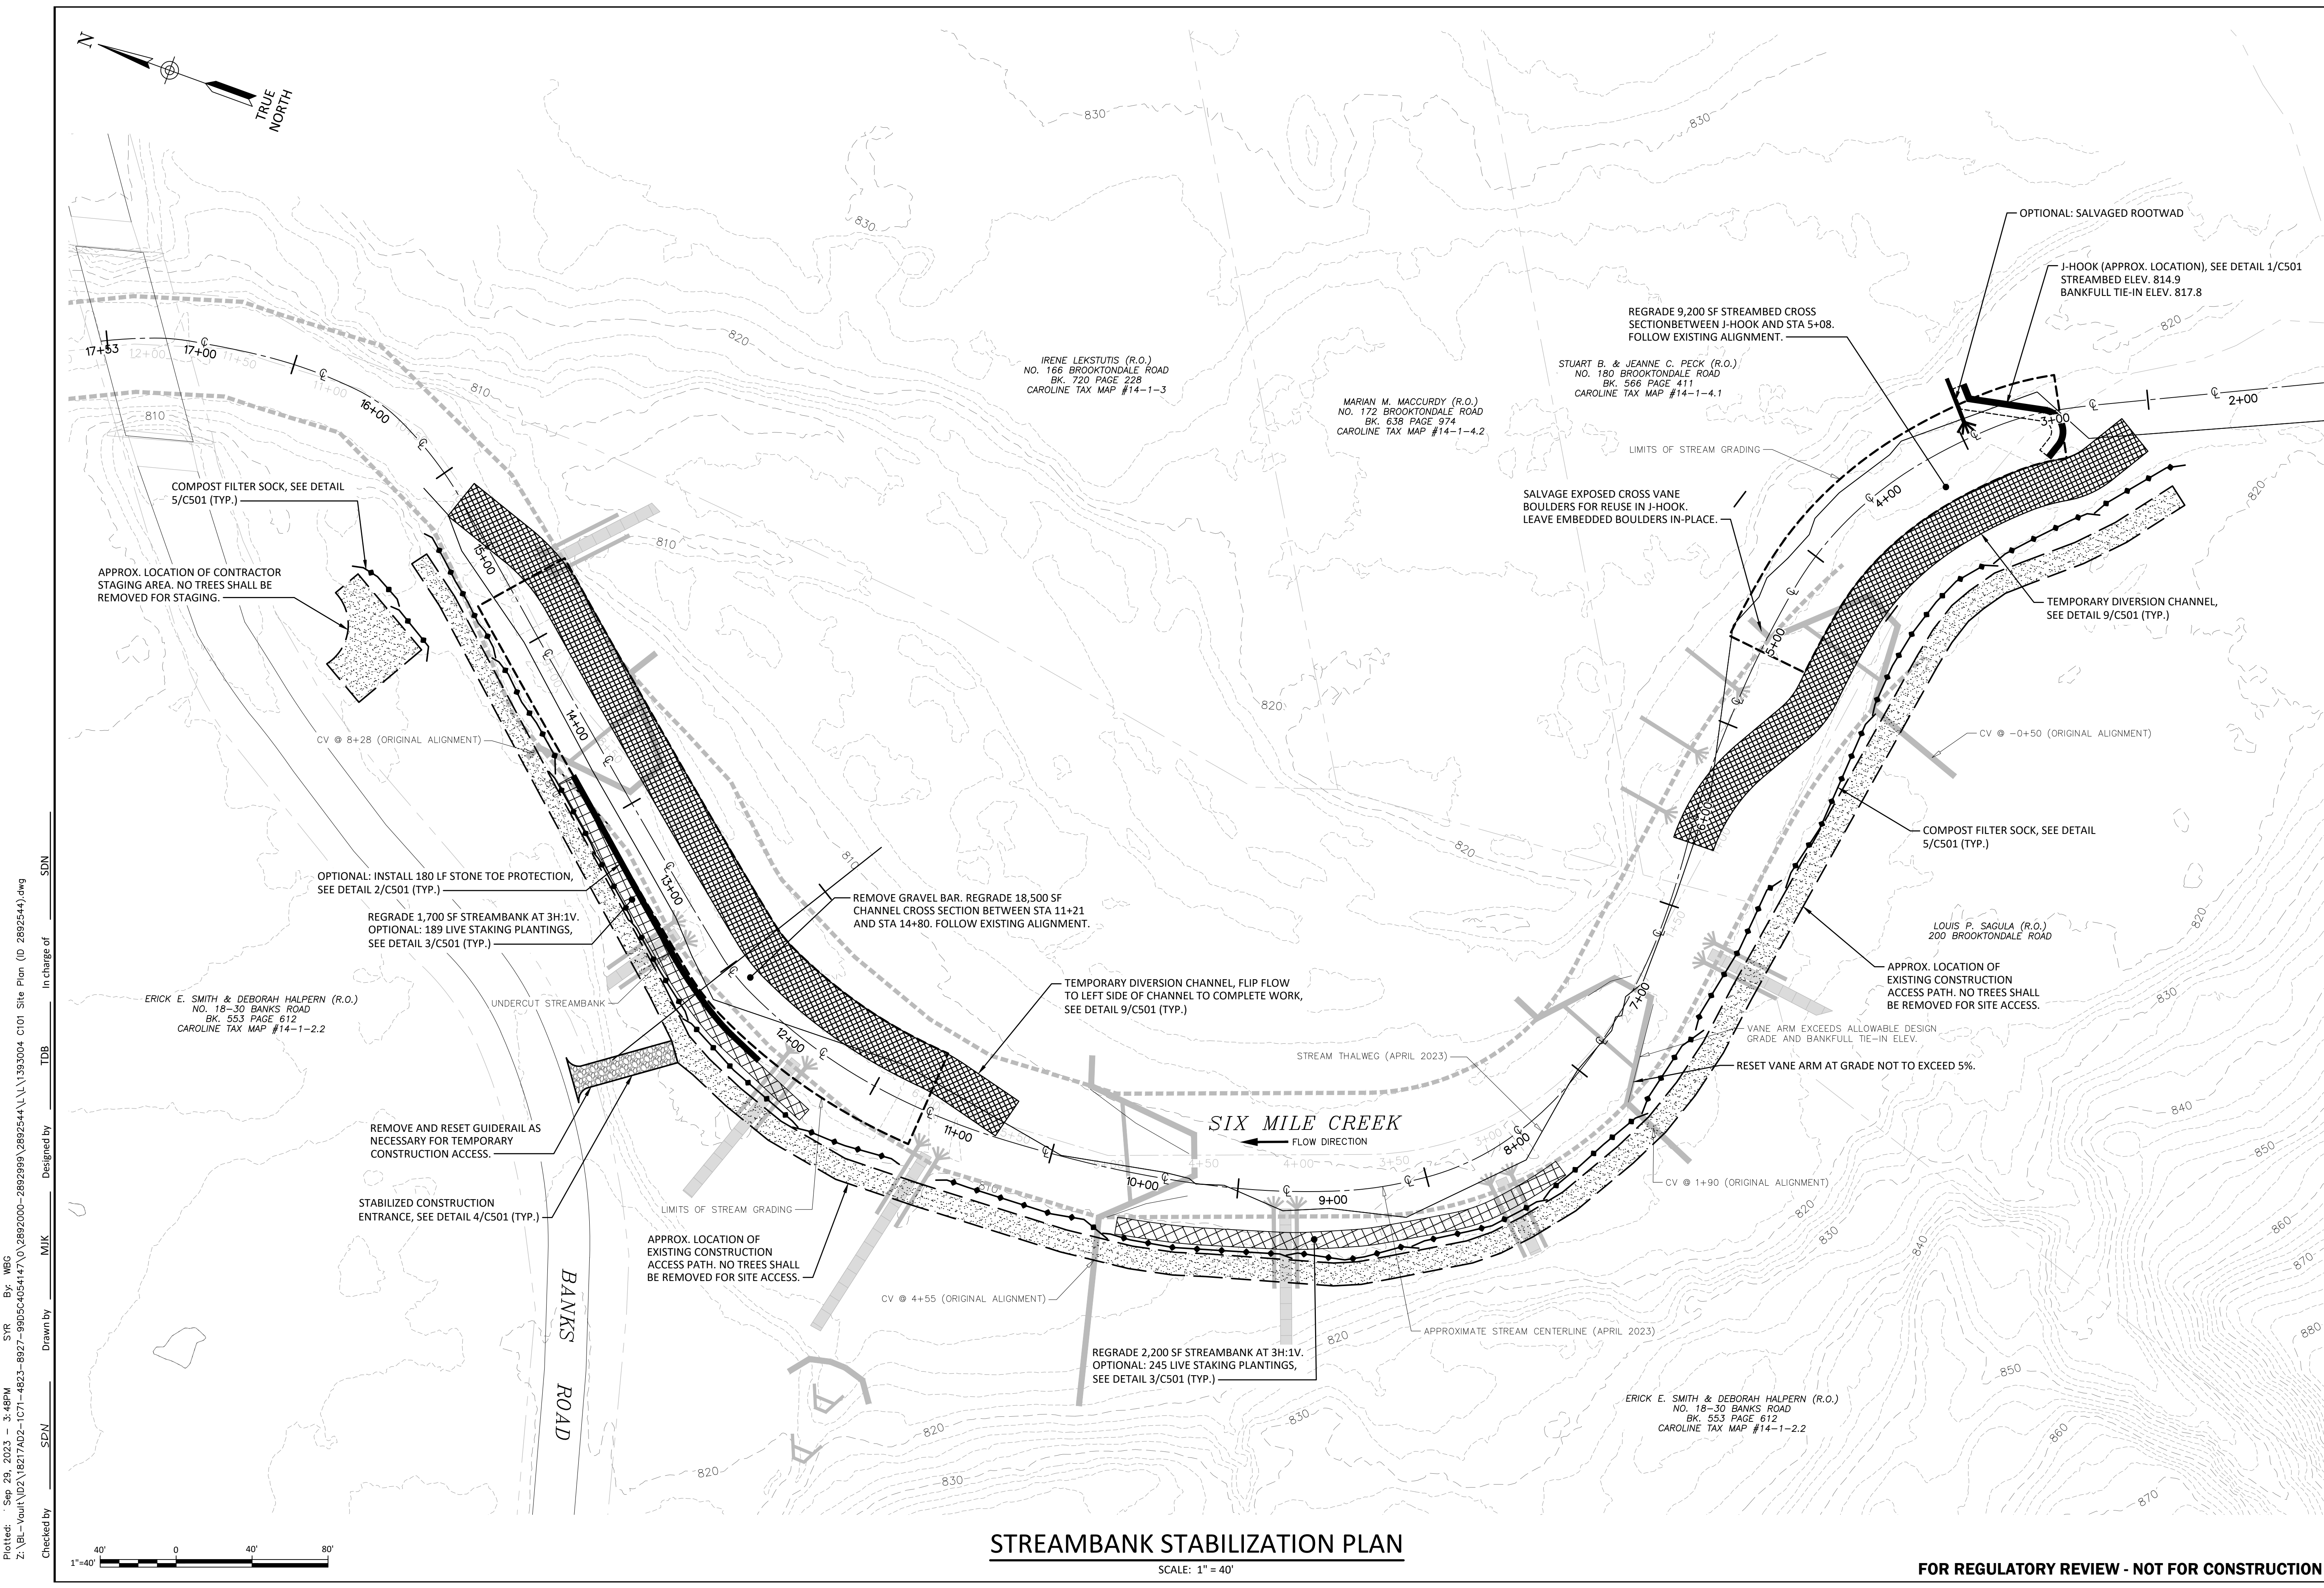

STREAMBANK STABILIZATION PLAN
SCALE: 1" = 40'

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REVISIONS	

SITE PLAN

TOMPKINS COUNTY SOIL AND WATER CONSERVATION DISTRICT
SIX MILE CREEK AT BANKS ROAD MAINTENANCE REPAIRS

TOWN OF CAROLINE
TOMPKINS COUNTY, NEW YORK

B&L

443 Electronics Parkway
Liverpool, NY
13088

Barton & Loguidice, D.P.C.




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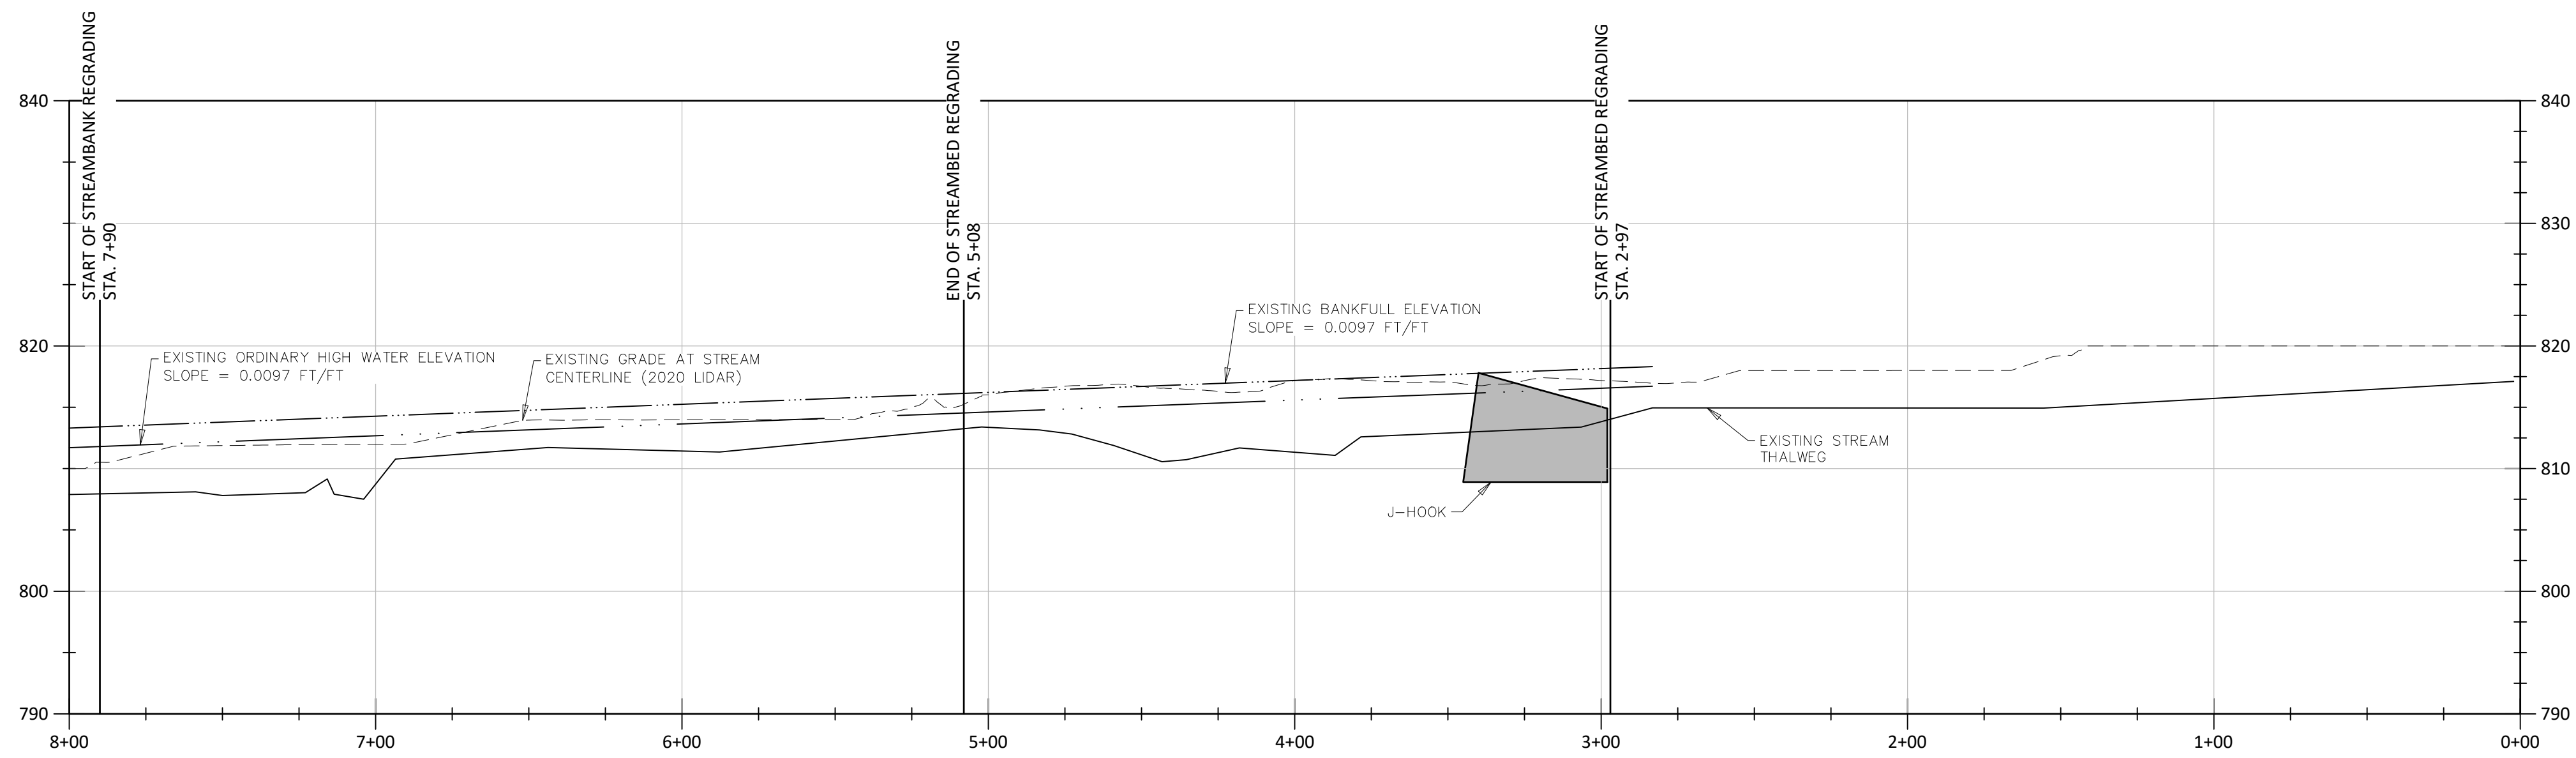
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 Checked by: SDN
 Drawn by: MJK
 Designed by: TDB
 In charge of: SDN




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Checked by SDN Drawn by MJK Designed by TDB In charge of SDN




STREAMBANK STABILIZATION PROFILE

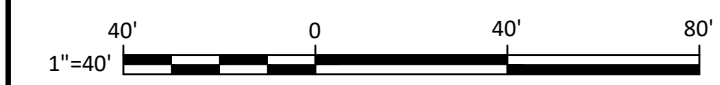HORIZONTAL SCALE: 1" = 40'
 VERTICAL SCALE: 1" = 10'

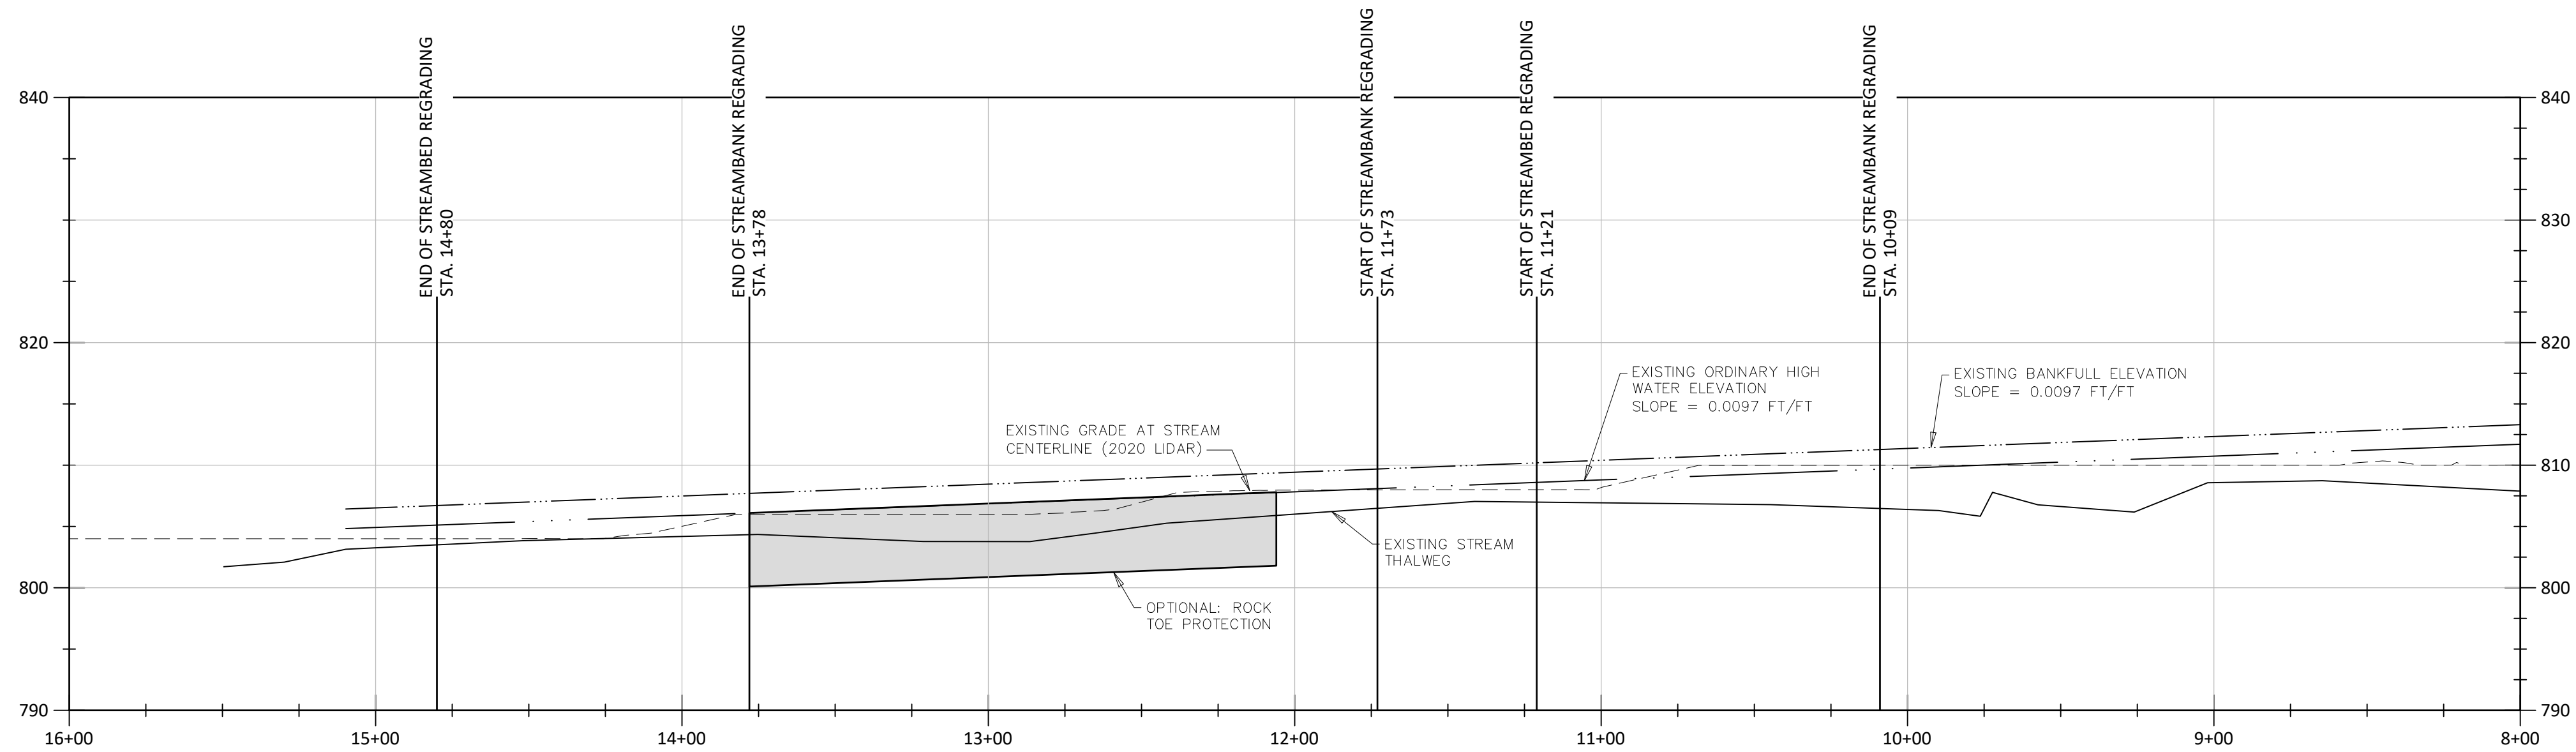

STREAMBANK STABILIZATION PROFILE

HORIZONTAL SCALE: 1" = 40'
 VERTICAL SCALE: 1" = 10'

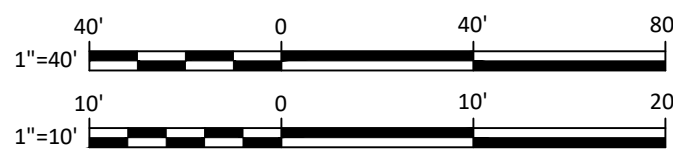


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REVISIONS	

TOMPKINS COUNTY SOIL AND WATER CONSERVATION DISTRICT
 SIX MILE CREEK AT BANKS ROAD MAINTENANCE REPAIRS
PROFILE
 TOMPKINS COUNTY, NEW YORK
 TOWN OF CAROLINE

443 Electronics Parkway
 Liverpool, NY
 13088
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Date: SEPTEMBER 2023
 Scale: AS SHOWN
 Sheet Number: C200
 Project Number: 1393.004.003

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REVISIONS	

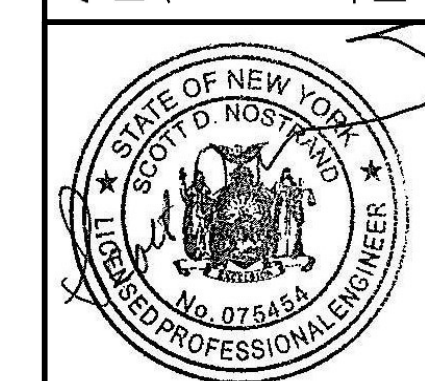
TOMPKINS COUNTY SOIL AND WATER CONSERVATION DISTRICT
SIX MILE CREEK AT BANKS ROAD MAINTENANCE REPAIRS

TOWN OF CAROLINE
TOMPKINS COUNTY, NEW YORK


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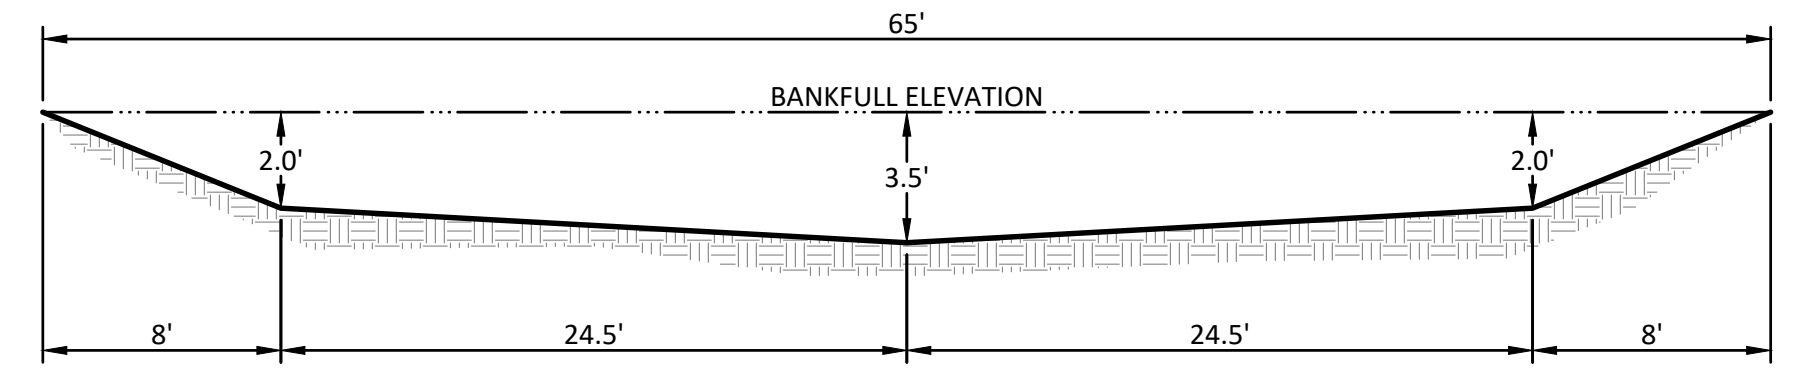
Date	SEPTEMBER 2023
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Project Number	1393.004.003




7 CROSS SECTION AT STA. 12+49
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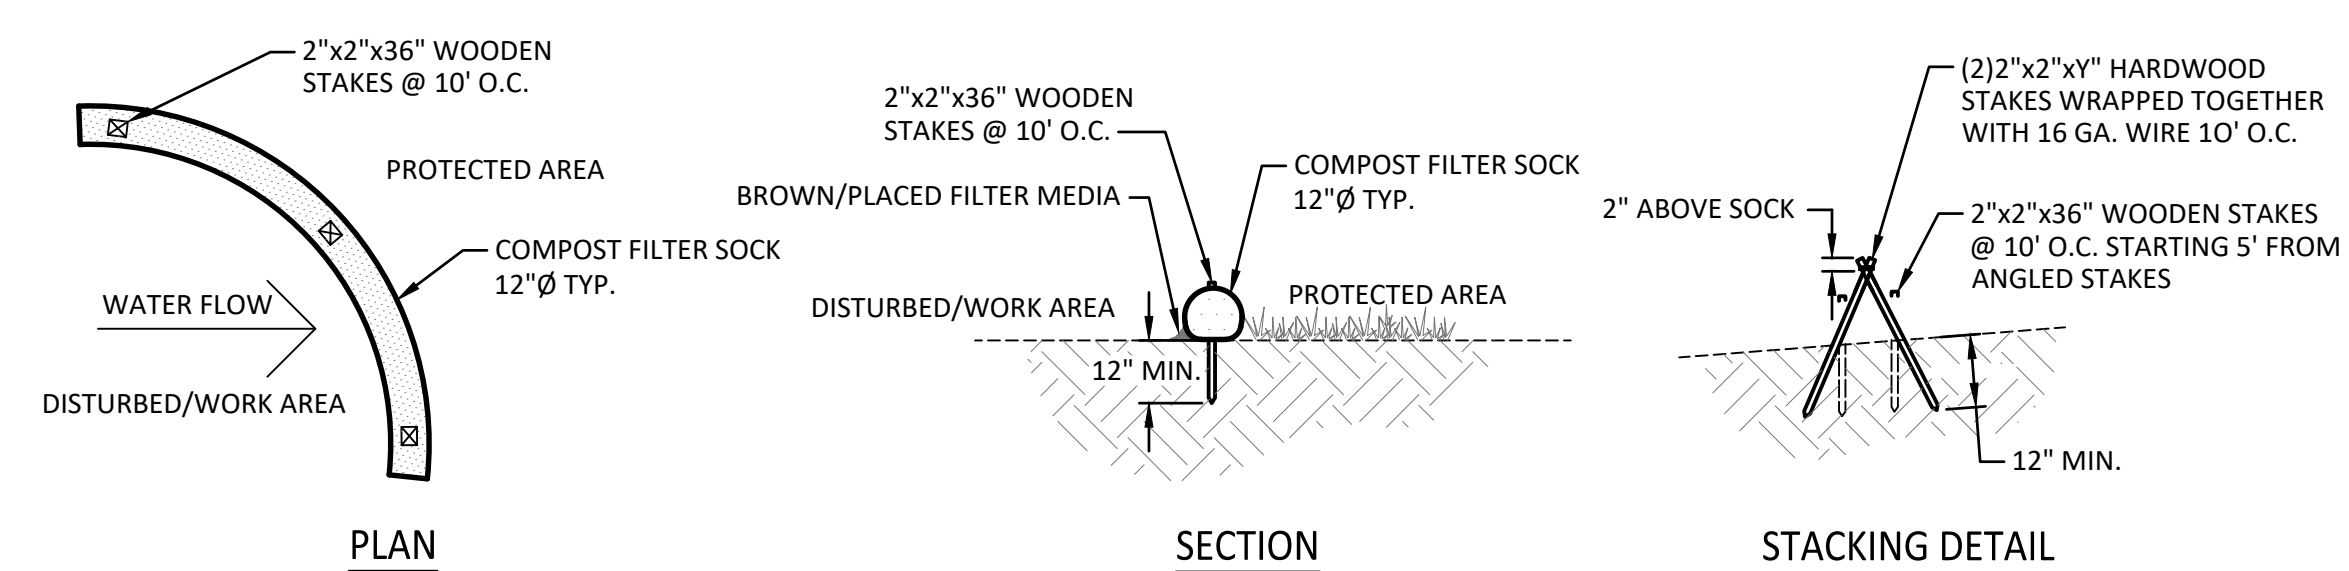
6 CROSS SECTION AT STA. 4+50
NOT TO SCALE

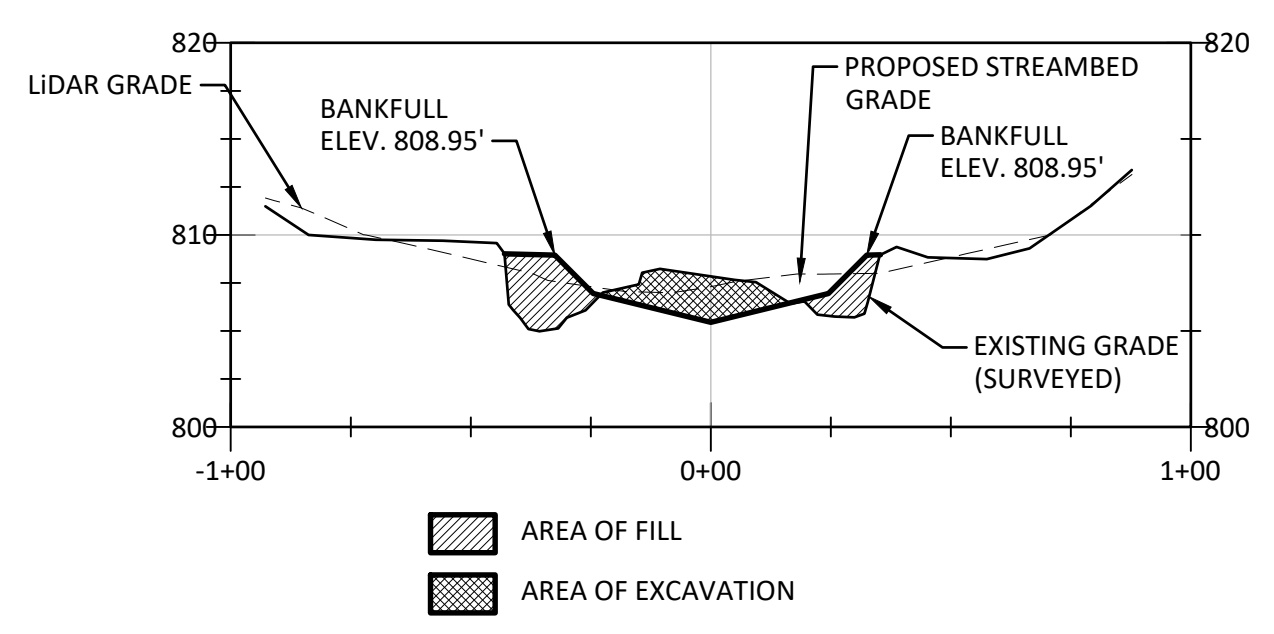

8 TYPICAL RIFFLE CROSS SECTION
NOT TO SCALE

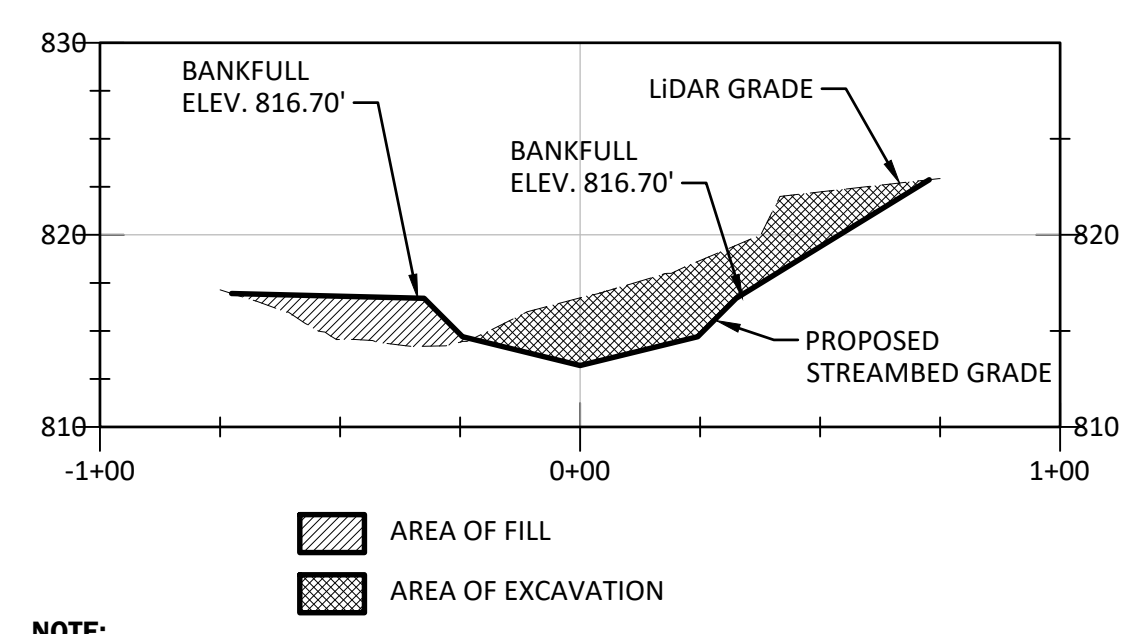

9 TEMPORARY DIVERSION CHANNEL CROSS SECTION
NOT TO SCALE

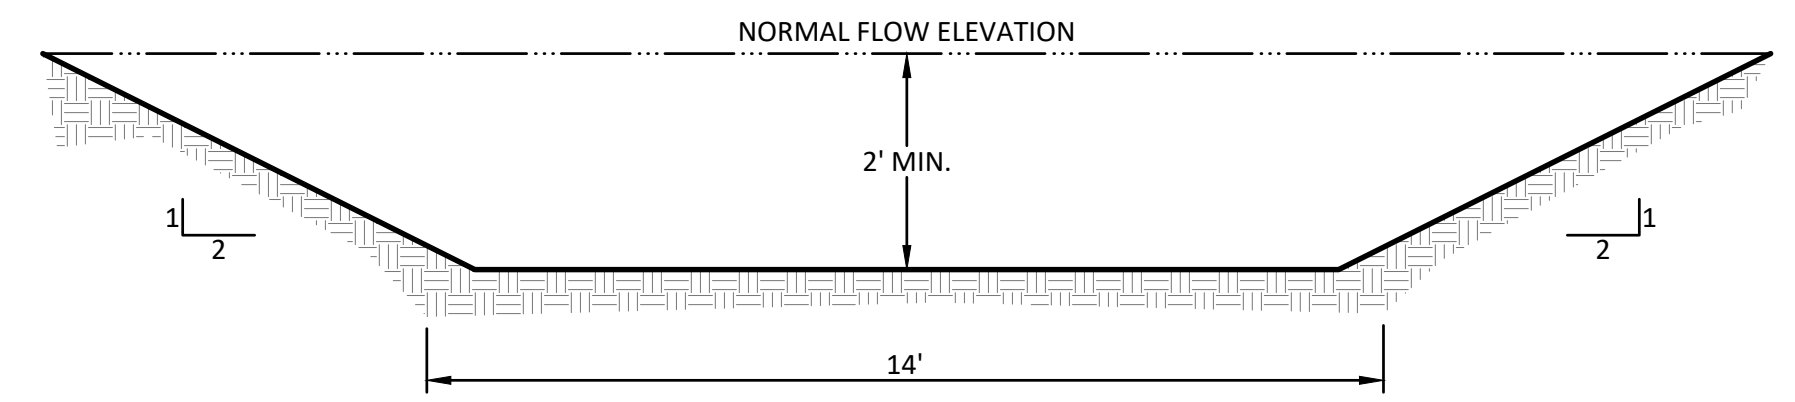


- NOTES:**
- COMPOST FILTER SOCKS ARE A TEMPORARY SEDIMENT CONTROL PRACTICE COMPOSED OF A DEGRADABLE GEOTEXTILE MESH TUBE FILLED WITH COMPOST FILTER MEDIA TO REDUCE RUNOFF VELOCITY, FILTER SEDIMENT AND OTHER POLLUTANTS ASSOCIATED WITH CONSTRUCTION ACTIVITY, AND TO PREVENT THEIR MIGRATION OFFSITE.
 - FILTER SOCKS CAN BE USED IN SENSITIVE AREAS WHERE CONTROL OF WEEDS AND INVASIVE PLANT SPECIES IS DESIRED.
 - FILTER SOCKS SHALL BE INSTALLED ON A LINE OF EQUAL ELEVATION (CONTOUR). THEY MAY BE INSTALLED AT INTERMEDIATE POINTS UP SLOPES AS WELL AS AT THE BOTTOM. ALL TERMINAL ENDS SHALL EXTEND 10 FEET UPSLOPE AT A 30° ANGLE TO PREVENT BYPASS FLOW.
 - FILTER SOCKS SHALL NOT BE USED IN OR ACROSS A FLOWING NATURAL CHANNEL. REFER TO CHECK DAM DETAIL AND SPECIFICATION.
 - FILTER SOCKS ARE NOT TO BE INSTALLED SO THAT RUNOFF WILL FLOW ALONG THE FILTER SOCK IN A CONCENTRATED MANNER.
 - FILTER SOCKS SHALL BE PLACED A MINIMUM OF 2 FEET FROM TOE OF SLOPE, (5 FEET PREFERRED), TO PROVIDE ADEQUATE AREA FOR SEDIMENT STORAGE AND TO FACILITATE MAINTENANCE OF THE SEDIMENT CONTAINMENT AREA.
 - POSTS MAY BE 2" x 2" MIN. WOOD OR 2 kg/m MIN. STEEL. SPACING SHALL BE AS RECOMMENDED BY THE MANUFACTURER. FOR USE ON IMPERVIOUS SURFACES SUCH AS ROAD PAVEMENT OR PARKING AREAS, PROPER ANCHORAGE MUST BE PROVIDED TO PREVENT SHIFTING OF THE SOCK OR SEPARATION OF THE CONTACT BETWEEN THE SOCK AND THE PAVEMENT.
 - FILTER SOCKS SHALL BE BETWEEN 12" AND 32". THE MAXIMUM SLOPE LENGTH ABOVE A FILTER SOCK SHALL NOT EXCEED THE FOLLOWING


DIA.	SLOPE (%)				
	2	5	10	20	25
8"	225'	200'	100'	50'	20'
12"	250'	225'	125'	65'	40'
18"	275'	250'	150'	70'	45'
24"	350'	275'	200'	130'	60'
32"	450'	325'	275'	150'	75'

- MEASURES SHALL BE INSPECTED EVERY 7 CALENDAR DAYS, AFTER EACH RAINFALL OF 0.5" OR MORE WITHIN A 12 HOUR PERIOD, OR DAILY DURING PROLONGED RAINFALL. MEASURES SHALL BE CLEANED AND REPAIRED AS REQUIRED.
- ACCUMULATED SEDIMENT SHALL BE REMOVED WHEN IT REACHES ONE-HALF OF THE ABOVE GROUND HEIGHT. SEDIMENT SHALL BE DISPOSED OF AS UNSUITABLE MATERIAL.
- UPON STABILIZATION OF THE AREA TRIBUTARY TO THE FILTER SOCK, STAKES SHALL BE REMOVED. THE SOCK MAY BE LEFT IN PLACE AND VEGETATED OR THE MESH CAN BE CUT AND THE COMPOST SPREAD AS AN ADDITIONAL MULCH TO ACT AS A SOIL SUPPLEMENT.
- MAXIMUM DRAINAGE AREA TRIBUTARY TO 100' OF FILTER SOCK SHALL BE 0.5 ACRE

5 COMPOST FILTER SOCK
NOT TO SCALE

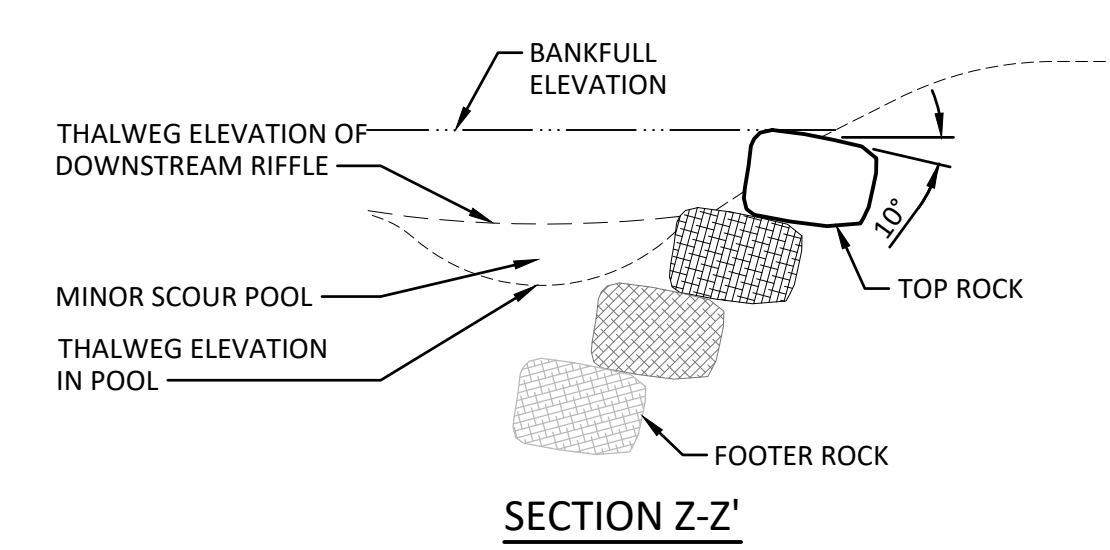


SECTION Z-Z'

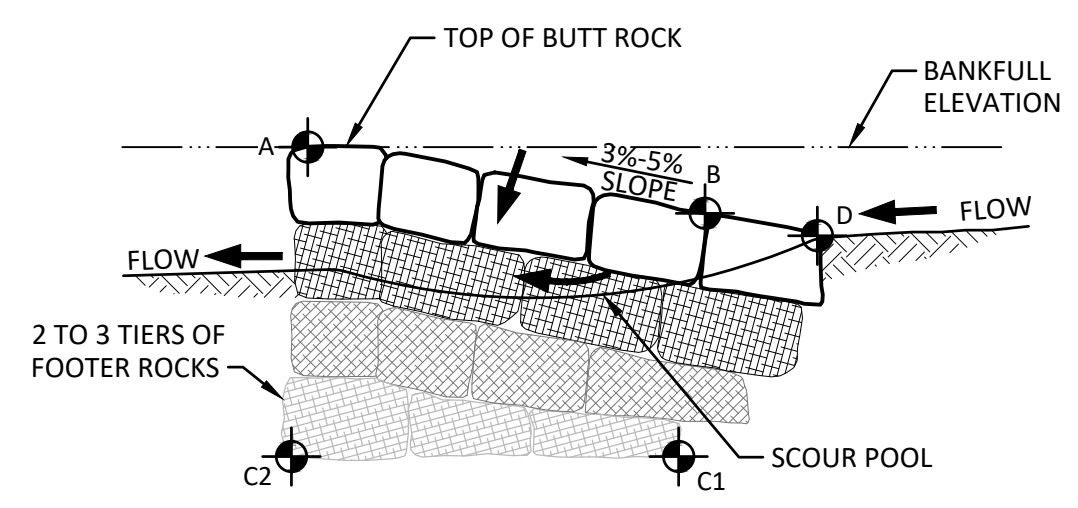


PROFILE Y-Y'

- NOTES:**
- FOOTER ROCKS SHALL BE KEYED INTO BED AT THE PROPER DEPTH SUCH THAT THE UPPER TIER OF ROCK (VANE ROCKS) MAINTAINS THE FOLLOWING SPECIFICATIONS:
 - TOP OF BUTT ROCK IS SET AT DESIRED ELEVATION.
 - UPSTREAM END OF ARM ROCKS MEET THE DESIRED LOW FLOW ELEVATION AT ONE-THIRD THE CHANNEL WIDTH.
 - ARMS EXTEND DOWNSTREAM FROM THROAT TO BUTT ROCK AT A CONTINUOUS SLOPE OF 3% - 5%.
 - ARMS ARE SET AT A 20° TO 30° ANGLE IN RESPECT TO THE NEAR BANK (SEE VANE DETAIL, PLAN VIEW, ON THIS SHEET).

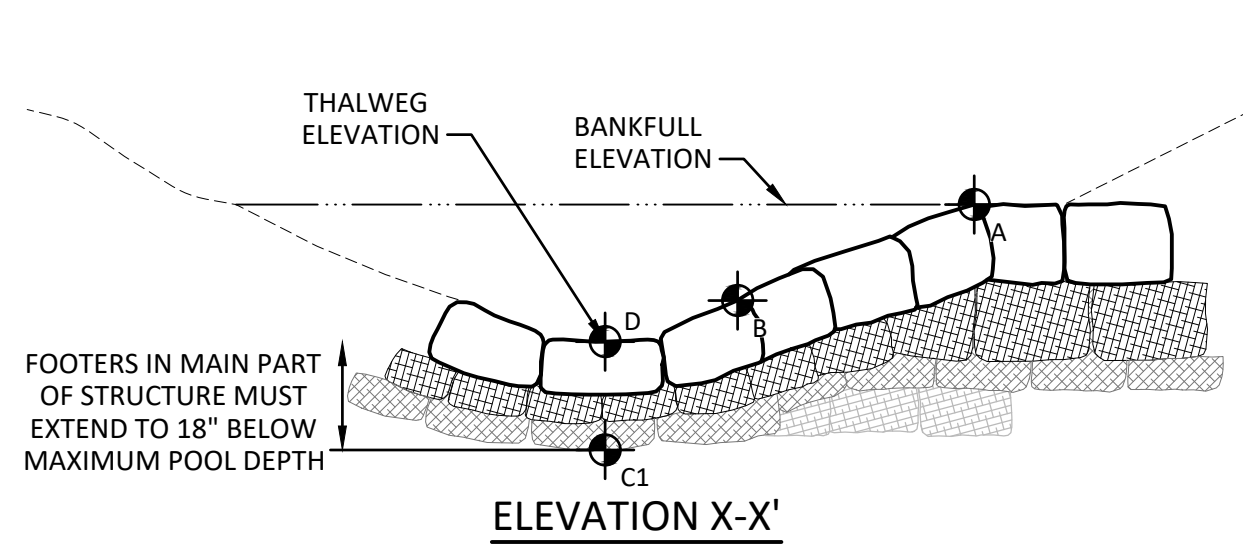


ELEVATION X-X'

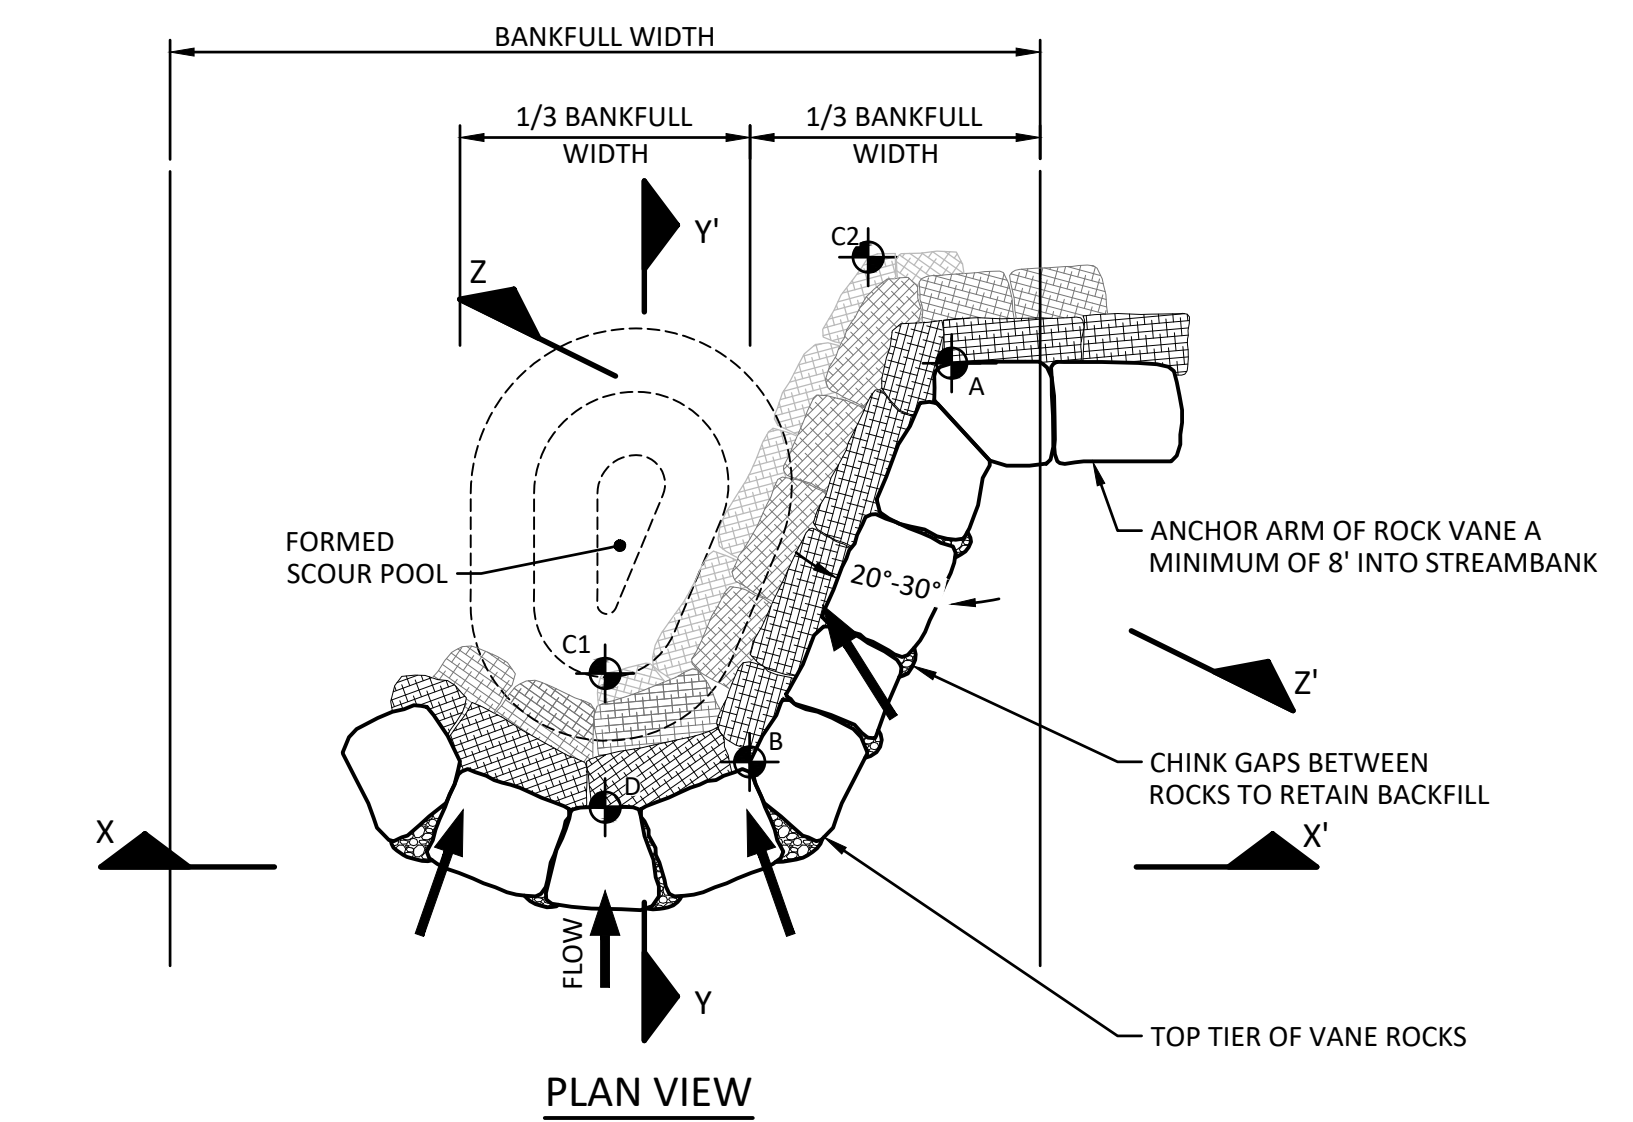


PLAN VIEW

CONSTRUCTION POINT	NORTHING	EASTING	STATION	OFFSET	LT/RT	ELEVATION	LENGTH
A	872022.6478	864404.6860	3+40.24	18.10	RT	817.8	40.9
B	871982.6131	864412.8871	3+05.26	0.21	LT	816.1	
C1	871976.4473	864406.7257	3+03.07	8.66	LT	808.9	
C2	872024.2899	864399.7562	3+44.58	15.69	RT	808.9	
D	871973.0810	864409.7120	2+98.43	7.73	LT	814.9	-

1 J-HOOK ROCK VANE
NOT TO SCALE

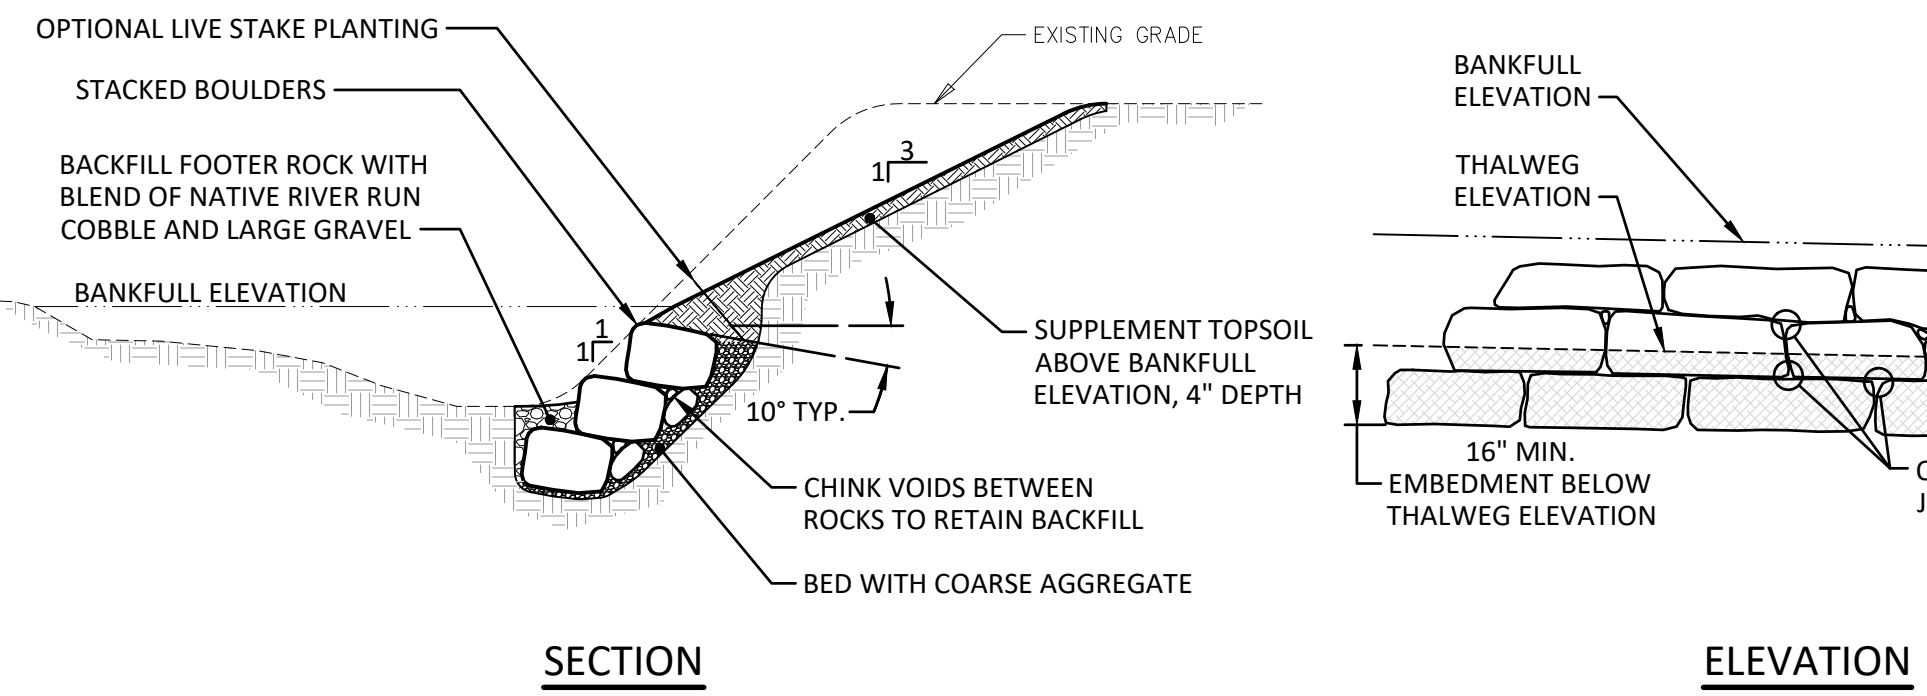


2 STONE TOE PROTECTION
NOT TO SCALE

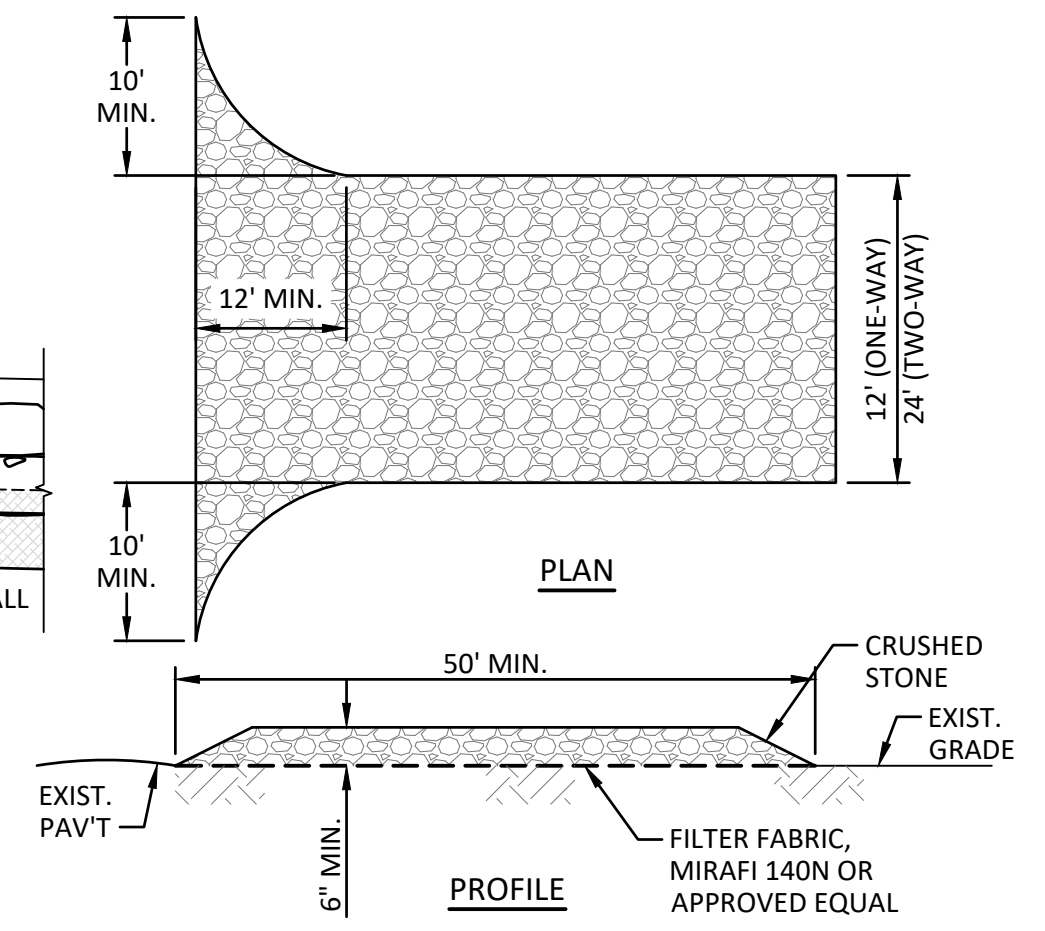

- STABILIZED CONSTRUCTION ACCESS NOTES:**
- MODIFICATIONS MAY BE REQUIRED TO MEET FIELD CONDITIONS.
 - PROPOSED DRAINAGE PIPES SHALL BE SIZED WITH SUFFICIENT CAPACITY TO CARRY DITCH FLOWS.
 - ALTERNATIVE WAYS OF TRANSPORTING DITCH DRAINAGE ACROSS CONSTRUCTION ENTRANCES MAY BE PROPOSED BY THE CONTRACTOR FOR APPROVAL BY THE OWNER'S REPRESENTATIVE.
 - ALL WORK TO CONSTRUCT THE STABILIZED ENTRANCE, INCLUDING GRADING, DRAINAGE PIPE, EXCAVATION, FILL, GEOTEXTILE, CRUSHED STONE, GRAVEL, CORRUGATED STEEL PANELS SHALL BE INCLUDED IN THE LUMP SUM BID ITEM.
 - GEOTEXTILE SHALL BE PLACED OVER THE ENTIRE AREA OF STABILIZED CONSTRUCTION ENTRANCE PRIOR TO PLACING STONE. STONE SHALL MEET THE REQUIREMENTS OF NYSDOT ITEM 623.12, CRUSHED NO. 3 STONE.
 - ALL SURFACE WATER SHALL BE DIVERTED AWAY FROM CONSTRUCTION ENTRANCE. A MOUNTABLE BERM WITH 5:1 SLOPE IS PERMITTED.
 - THE ENTRANCE SHALL BE MAINTAINED IN A CONDITION WHICH WILL PREVENT TRACKING OR FLOWING OF SEDIMENT ONTO PUBLIC RIGHT OF WAY. ALL SEDIMENT SPILLED, DROPPED, WASHED OR TRACKED ONTO PUBLIC RIGHT OF WAY MUST BE REMOVED IMMEDIATELY.
 - WHEN WASHING IS REQUIRED, IT SHALL BE DONE ON AN AREA WITH STONE AND WHICH DRAINS ONTO AN APPROVED SEDIMENT TRAPPING DEVICE (OR CORRUGATED STEEL PANELS).
 - PERIODIC INSPECTION AND NEEDED MAINTENANCE SHALL BE DONE REGULARLY AND FOLLOWING EACH RAINFALL.

4 STABILIZED CONSTRUCTION ENTRANCE/EXIT
NOT TO SCALE

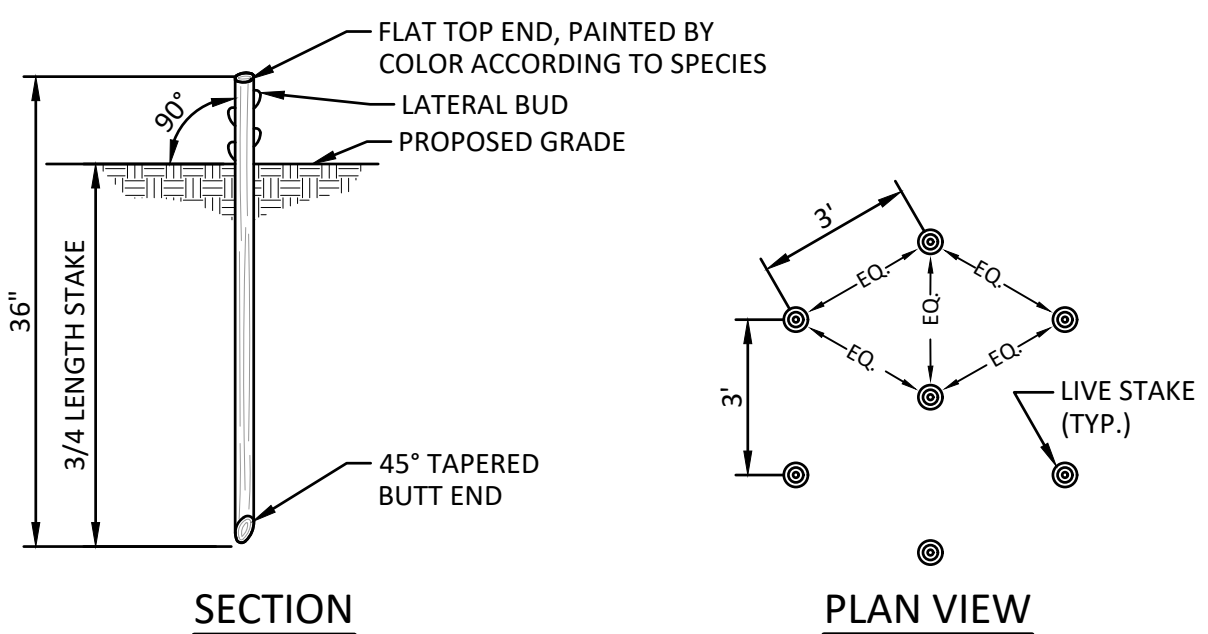

3 LIVE STAKE PLANTING
NOT TO SCALE

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